



PROJECT #:	0515
DATE DRAWN:	05-15-95
NO.:	REVISION: BY:
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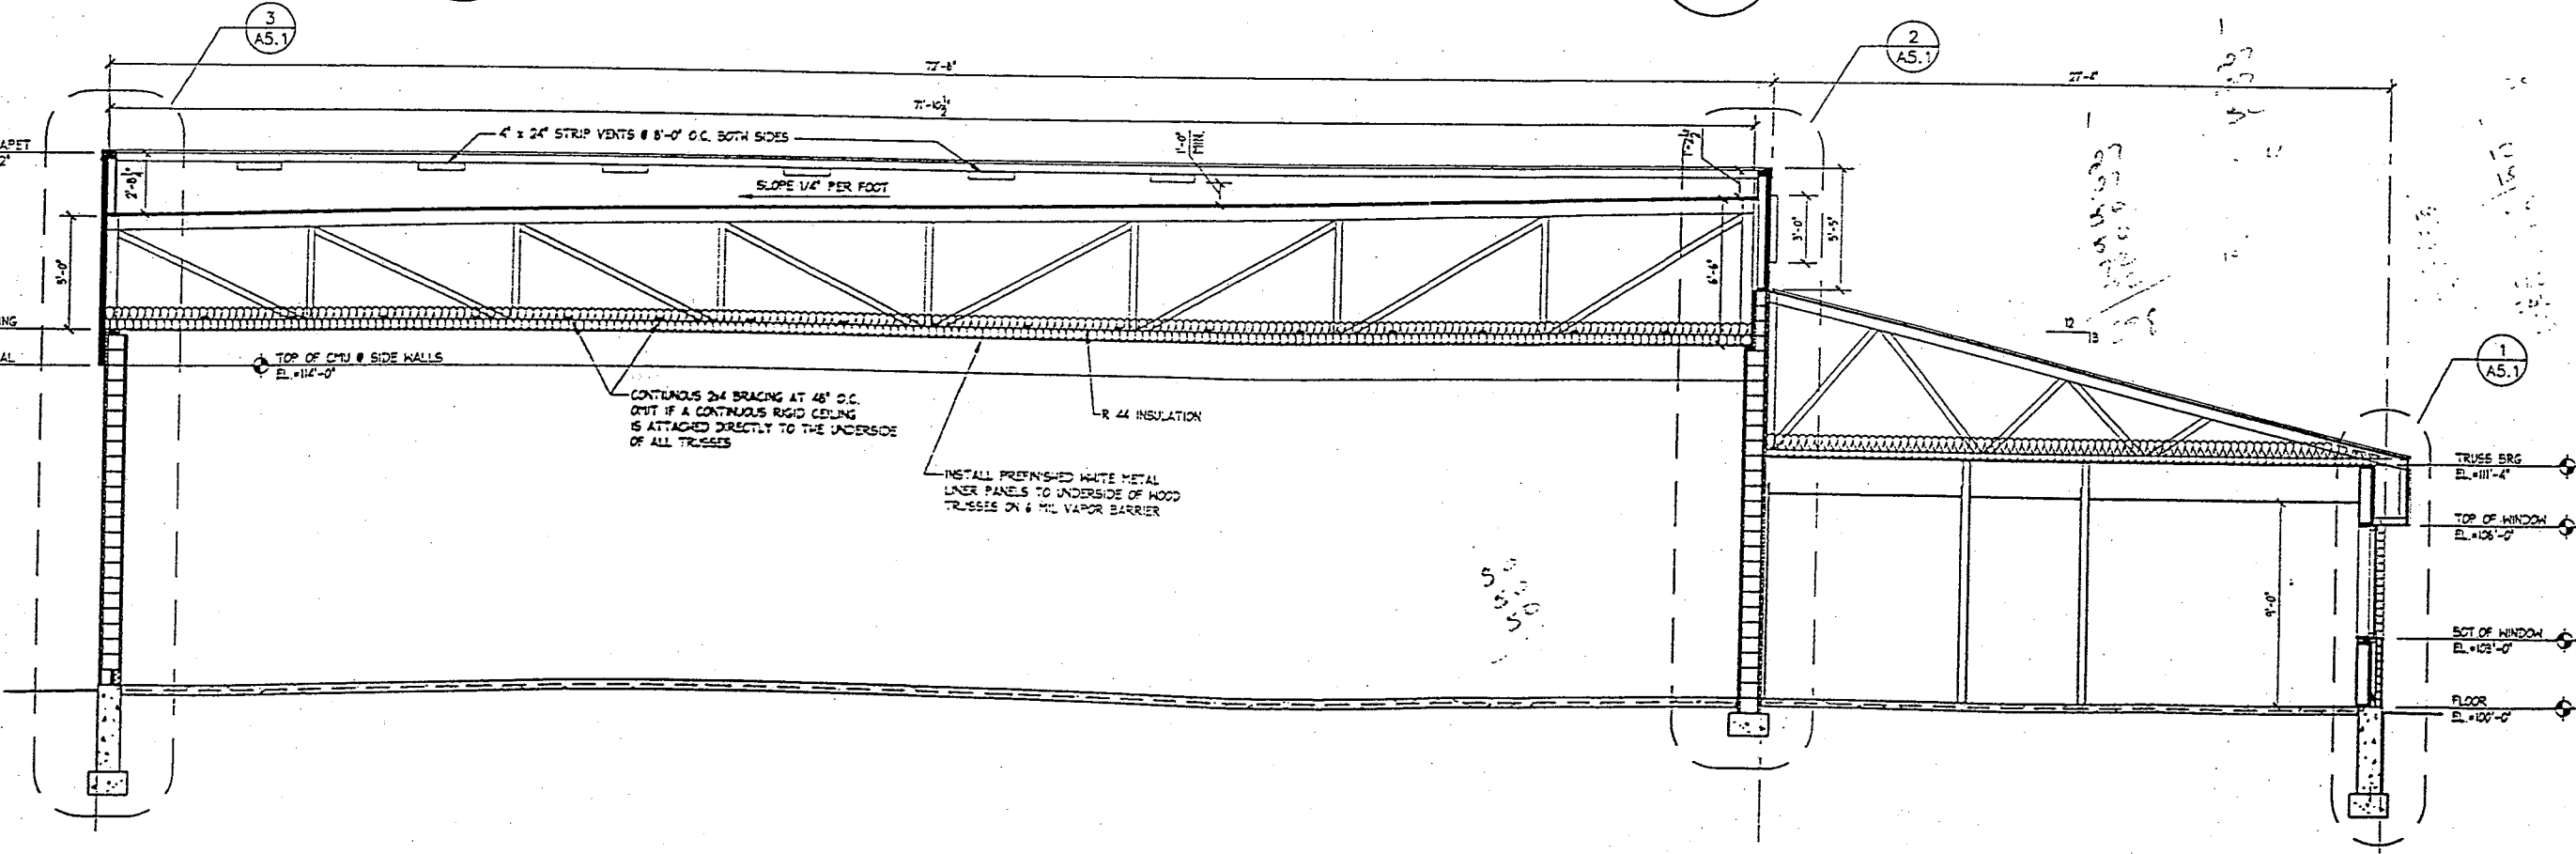
A-4.1

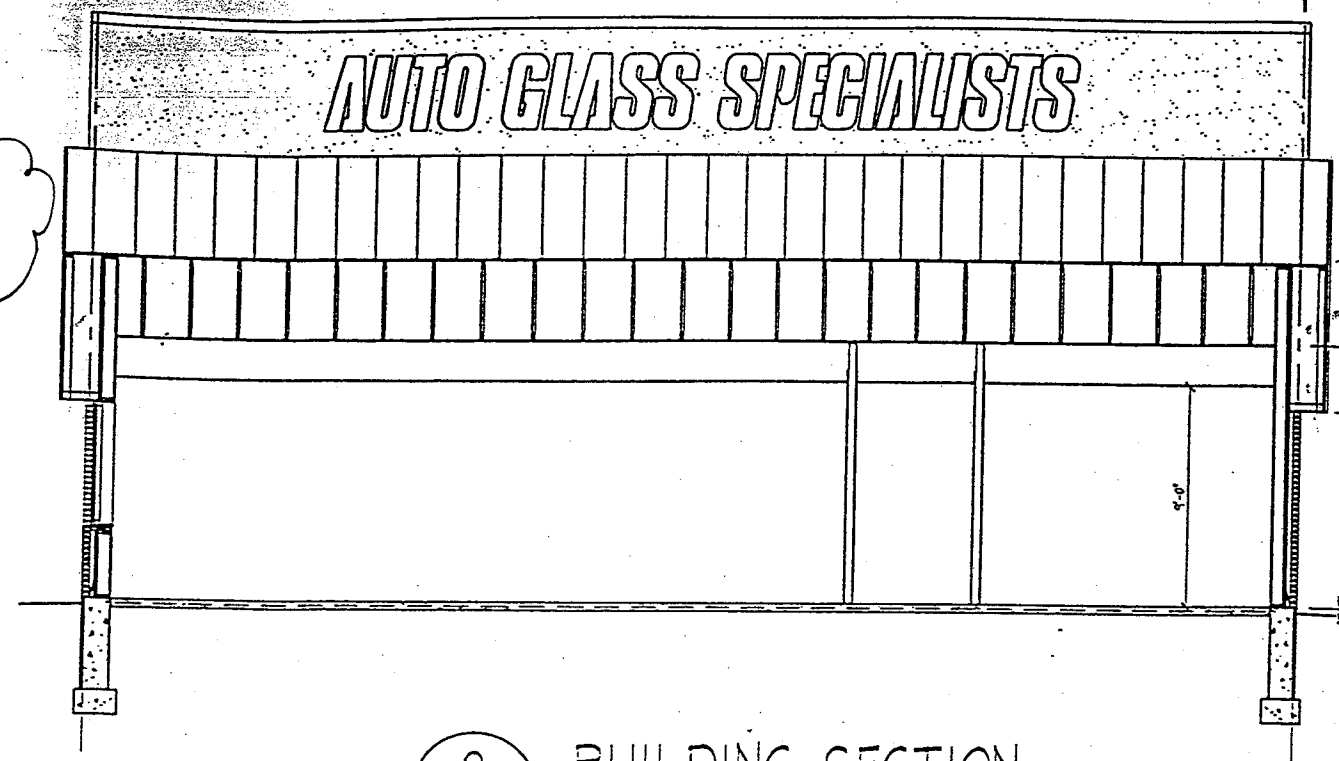


2 BUILDING SECTION
A-4.1 SCALE: 1/8"=1'-0"

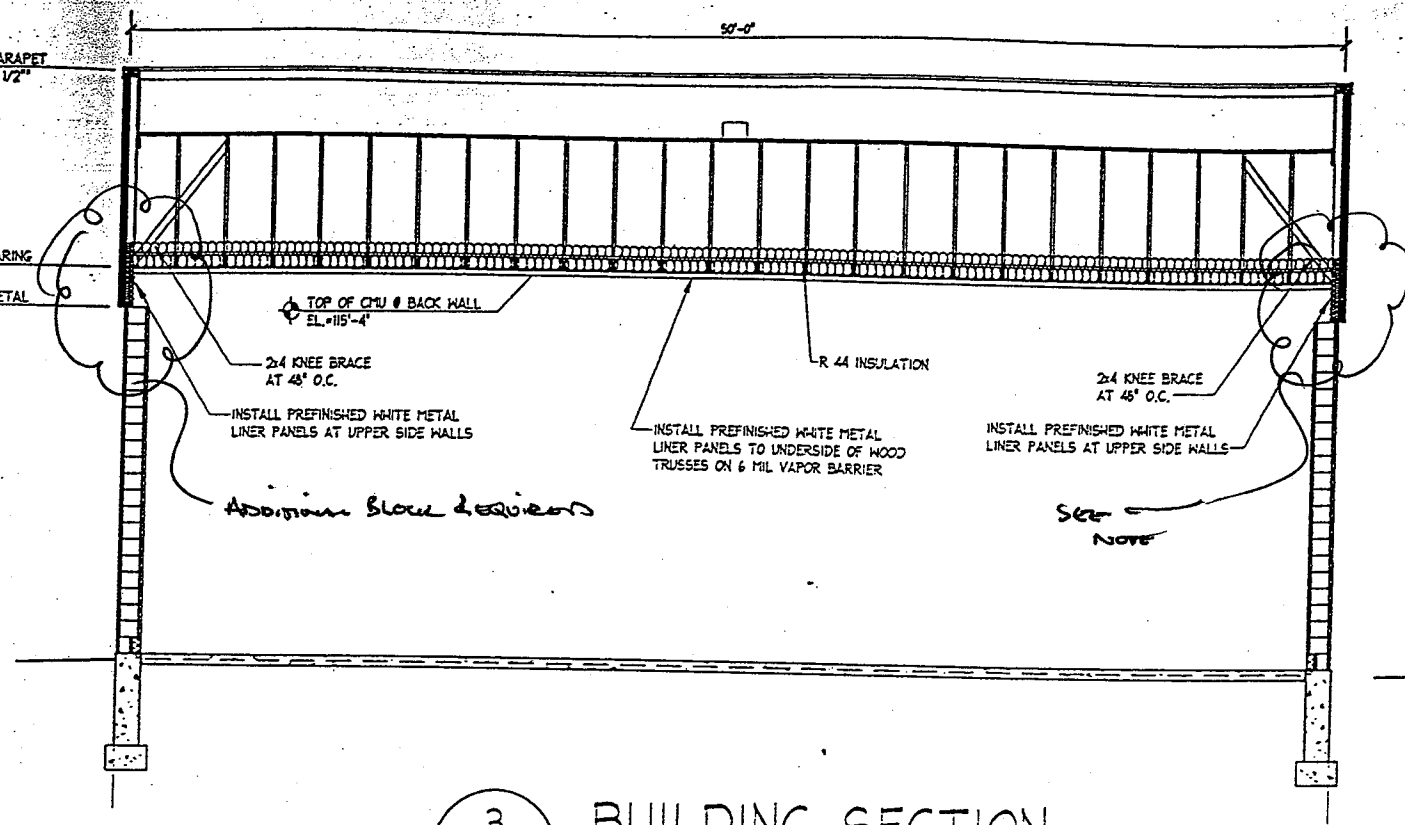

3 BUILDING SECTION
A-4.1 SCALE: 1/8"=1'-0"



1 BUILDING SECTION
A-4.1 SCALE: 1/8"=1'-0"

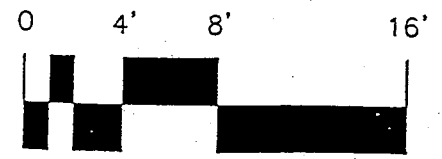


8025 EXCELSOR DRIVE
 MADISON WI
 (608) 608-236-5818
 53717-1945
DESIGN - BUILD ARCHITECTURE CONSTRUCTION

AGS SERVICE CENTER PROTOTYPE
 AUTO GLASS SPECIALISTS
 1200 JOHN G. HARTIGS DRIVE
 MADISON, WI 53717

PROJECT #: 9815
 DATE DRAWN: 05-15-98
 NO. REVISION BY:
 06-05-98 KJB
 ISSUE DATES:
 REVIEW DATES:
 ARCHITECTURAL:
 CONSTRUCTION:
 DRAWN BY: KJB
 DRAWING NUMBER

S-2.1

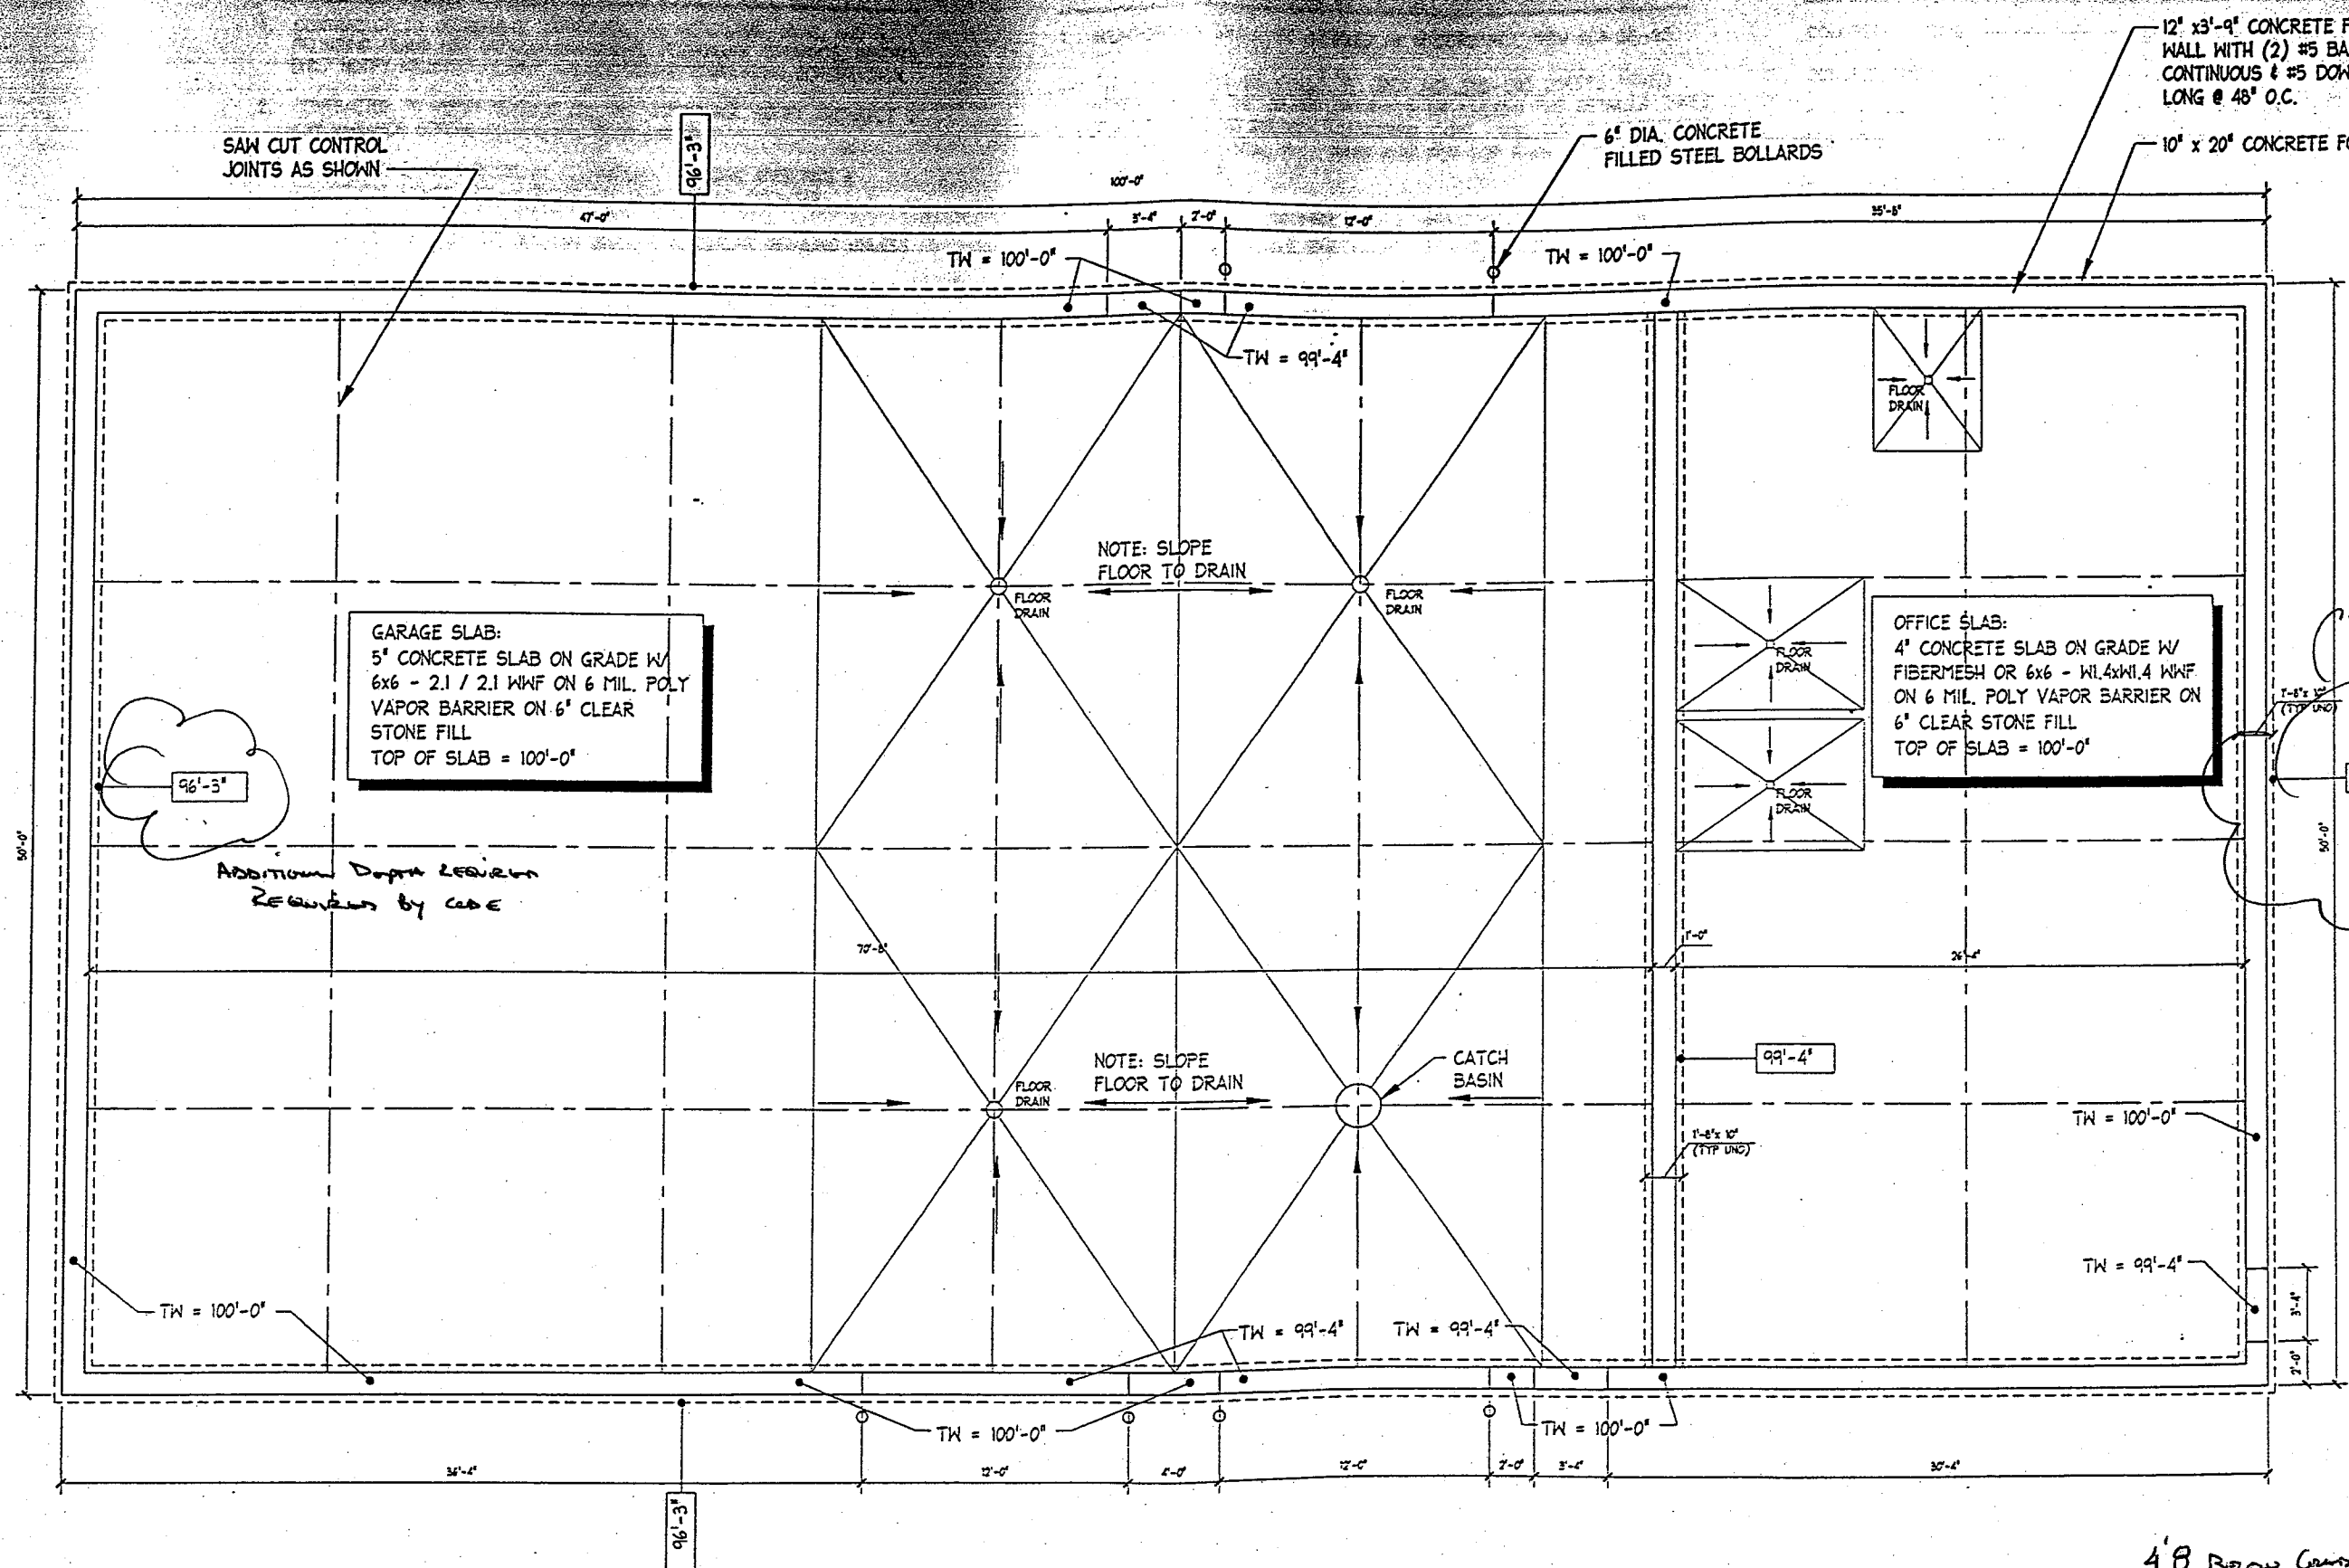

SAW CUT CONTROL JOINTS AS SHOWN

6" DIA. CONCRETE FILLED STEEL BOLLARDS

12" x 3'-9" CONCRETE FOUNDATION WALL WITH (2) #5 BARS TOP & BOT CONTINUOUS & #5 DOWELS x 8" LONG @ 48" O.C.

10" x 20" CONCRETE FOOTING

GARAGE SLAB:
 5" CONCRETE SLAB ON GRADE W/
 6x6 - 2.1 / 2.1 WWF ON 6 MIL. POLY
 VAPOR BARRIER ON 6" CLEAR
 STONE FILL
 TOP OF SLAB = 100'-0"

OFFICE SLAB:
 4" CONCRETE SLAB ON GRADE W/
 FIBERMESH OR 6x6 - W1.4xW1.4 WWF
 ON 6 MIL. POLY VAPOR BARRIER ON
 6" CLEAR STONE FILL
 TOP OF SLAB = 100'-0"

NOTE: SLOPE FLOOR TO DRAIN

NOTE: SLOPE FLOOR TO DRAIN

Additional Depth Required by Code

Attention to be given by contractor

4'8" Below Grade

1 FOUNDATION PLAN
 S-2.1 SCALE: 1/8" = 1'-0"

